


ENGINEERING STANDARDS 2025			
REVISIONS		ENGINEERING DIVISION CITY OF POMPANO BEACH	CURB INLET SEDIMENT BARRIER
BY	DATE		
SCALE: N.T.S.		DATE: MAY 2022	507-1
		DWG. NO.	




ENGINEERING STANDARDS 2025			
REVISIONS		ENGINEERING DIVISION CITY OF POMPANO BEACH	CURB AND GUTTER SEDIMENT BARRIER
BY	DATE		
		SCALE: N.T.S.	DATE: MAY 2022
			DWG. NO.
			507-2

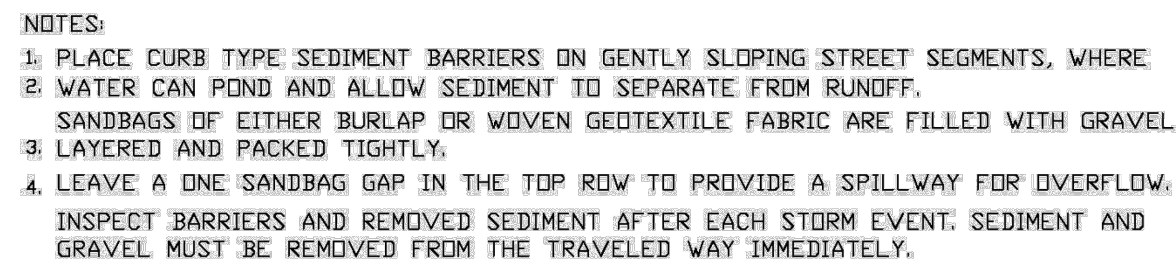

FILTER FABRIC
DROP INLET SEDIMENT FILTER

ENGINEERING STANDARDS 2025				
REVISIONS		ENGINEERING DIVISION CITY OF POMPAÑO BEACH	FILTER FABRIC DROP INLET SEDIMENT FILTER	
BY	DATE		<div>DATE: MAY 2022</div> <div>DWG. NO. 508-1</div>	
SCALE: N.T.S.				

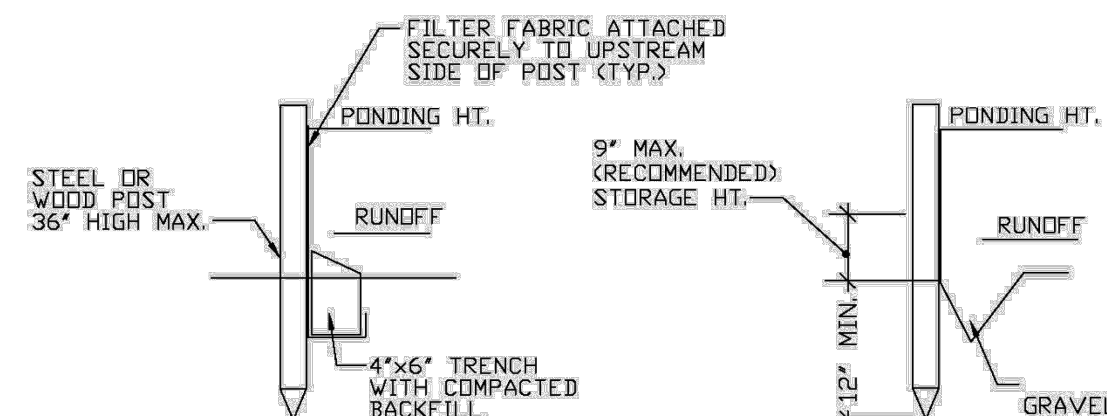

SILT FENCE

1. SILT FENCE AND TURBIDITY BARRIERS MUST REMAIN IN PLACE AND BE MAINTAINED AT ALL LOCATIONS SHOWN IN THE DRAWINGS UNTIL CONSTRUCTION IS COMPLETED AND SOILS ARE STABILIZED AND VEGETATION HAS BEEN.
2. CONTRACTOR SHALL SUBMIT SCHEDULE FOR THE INSTALLATION, INSPECTION AND MAINTENANCE THE EROSION CONTROLS FEATURES AS SHOWN IN THE DRAWINGS OR AS DIRECTED BY THE DESIGN ENGINEER. THE SCHEDULE SHALL SPECIFICALLY SHALL SPECIFICALLY INDICATE THE SEQUENCE OF CLEARING, EARTH WORK, DRAINAGE, AND WHEN THE EROSION CONTROL FEATURES SHALL BE INSTALLED, INSPECTED, AND MAINTAINED. IT SHALL ALSO INCLUDE METHODS TO PREVENT POLLUTION OF STREAM, LAKES, TIDAL WATERS, CANALS, AND IMPOUNDMENTS. ESTABLISHED.

ENGINEERING STANDARDS 2025			
REVISIONS		ENGINEERING DIVISION CITY OF POMPAÑO BEACH	SILT FENCE
BY	DATE		
		SCALE: N.T.S.	DATE: MAY 2022
			DWG. NO.
			509-1

Date: 09/10/2025

This item has been digitally signed and sealed by Justin Thompson, PE, on the date adjacent to the seal.

Printed copies of this document are not considered signed and sealed and the signature must be verified on any electronic copies.

DRC SUBMITTAL
RISING TIDE
CAR WASH

2901 W. ATLANTIC BOULEVARD
POMPANO BEACH, FL 33069
CITY OF POMPAN0 BEACH BROWARD CO

Project No.	25-032
Date	09/10/2025
Scale	As Shown
Drawn By	UCS
Checked By	JT

Revisions		
No.	Description	Date

STORM WATER POLLUTION & PROTECTION NOTES & DETAILS